

FOR BIDDING

FURNISH PIPE AND INSTALL
.....
(DUCTILE IRON PUSH-ON RUBBER GASKET JOINT)
738 FT. - 12" WATER MAIN

PERMANENT PAVEMENT
.....
420 SQ. YDS. - 4" ASPHALTIC CONCRETE (SEE PAVEMENT NOTE)

BARRICADES AND TRAFFIC CONTROL
.....
LUMP SUM

SAWCUTTING
.....
1400 LIN. FT. - IN ASPHALT

FINISHING OF ROADWAY
.....
LUMP SUM

FURNISH, INSTALL, AND MAINTAIN EROSION CONTROL
.....
LUMP SUM

595 CU. YDS. EXCESS EXCAVATED MATERIAL

FURNISH PIPE AND INSTALL
.....
(HIGH-DENSITY POLYETHYLENE (DRILL))
(DIRECTIONAL DRILL INSTALLATION)
738 FT. - 12" WATER MAIN

PERMANENT PAVEMENT
.....
35 SQ. YDS. - 4" ASPHALTIC CONCRETE (SEE PAVEMENT NOTE)

BARRICADES AND TRAFFIC CONTROL
.....
LUMP SUM

SAWCUTTING
.....
60 LIN. FT. - IN ASPHALT

FINISHING OF ROADWAY
.....
LUMP SUM

FURNISH, INSTALL, AND MAINTAIN EROSION CONTROL
.....
LUMP SUM

80 CU. YDS. EXCESS EXCAVATED MATERIAL

W. COUNTY LINE RD. IS ON THE 2013 PAVING PROGRAM.
EXISTING PAVEMENT IN W. COUNTY LINE RD. IS V.T. ASPHALT
(1978), ON V.T. ASPHALT (1959)

FOR START OF PLAN NOTES SEE SHEET 1 OF 5, PLAN
FILE NO. 2012042.


WOOD POLE - POLE *89-00041 (LARGE SPIKE) (9700 BLOCK)
ELEV. 141.73

WOOD POLE - POLE *89-00039 (LARGE SPIKE),
ON S/S OF W. COUNTY LINE RD. (9900 BLOCK)
ELEV. 141.88

WOOD POLE - POLE *88-05226 (LARGE SPIKE) (N.W. CRNR. TAMERLANE)
ELEV. 140.40

GAS	0	SANITARY SEWER		STREET LIGHTING	
ELECTRIC	E	STORM SEWER		CITY UNDERGROUND CONDUIT -- CUC	
TELEPHONE	T	COMBINED SEWER		PROPOSED CURB / PVM	
CABLE TELEVISION	TV	WATER MAIN	W	PAVING LIMITS	X X X X
FIBER OPTICS	FO	WATER SERVICE		STRUCTURE / BUILDING	/ / / /
PROPOSED UTILITY		PRESSURE DISTRICT		FENCE	X


POWER POLES ○-CONCRETE ◐-ALUMINUM ◑-WOOD **WATER MAIN VALVES** ⊕-GATE ⊖-BUTTERFLY ○W-SERVICE
UTILITIES ⊞-TRAFFIC SIGNAL ⊞-TRAFFIC CONTROL BOX ♂^G-GAS VALVE **HYDRANTS** ⦿-1 NOZZLE ⦿-3 NOZZLE

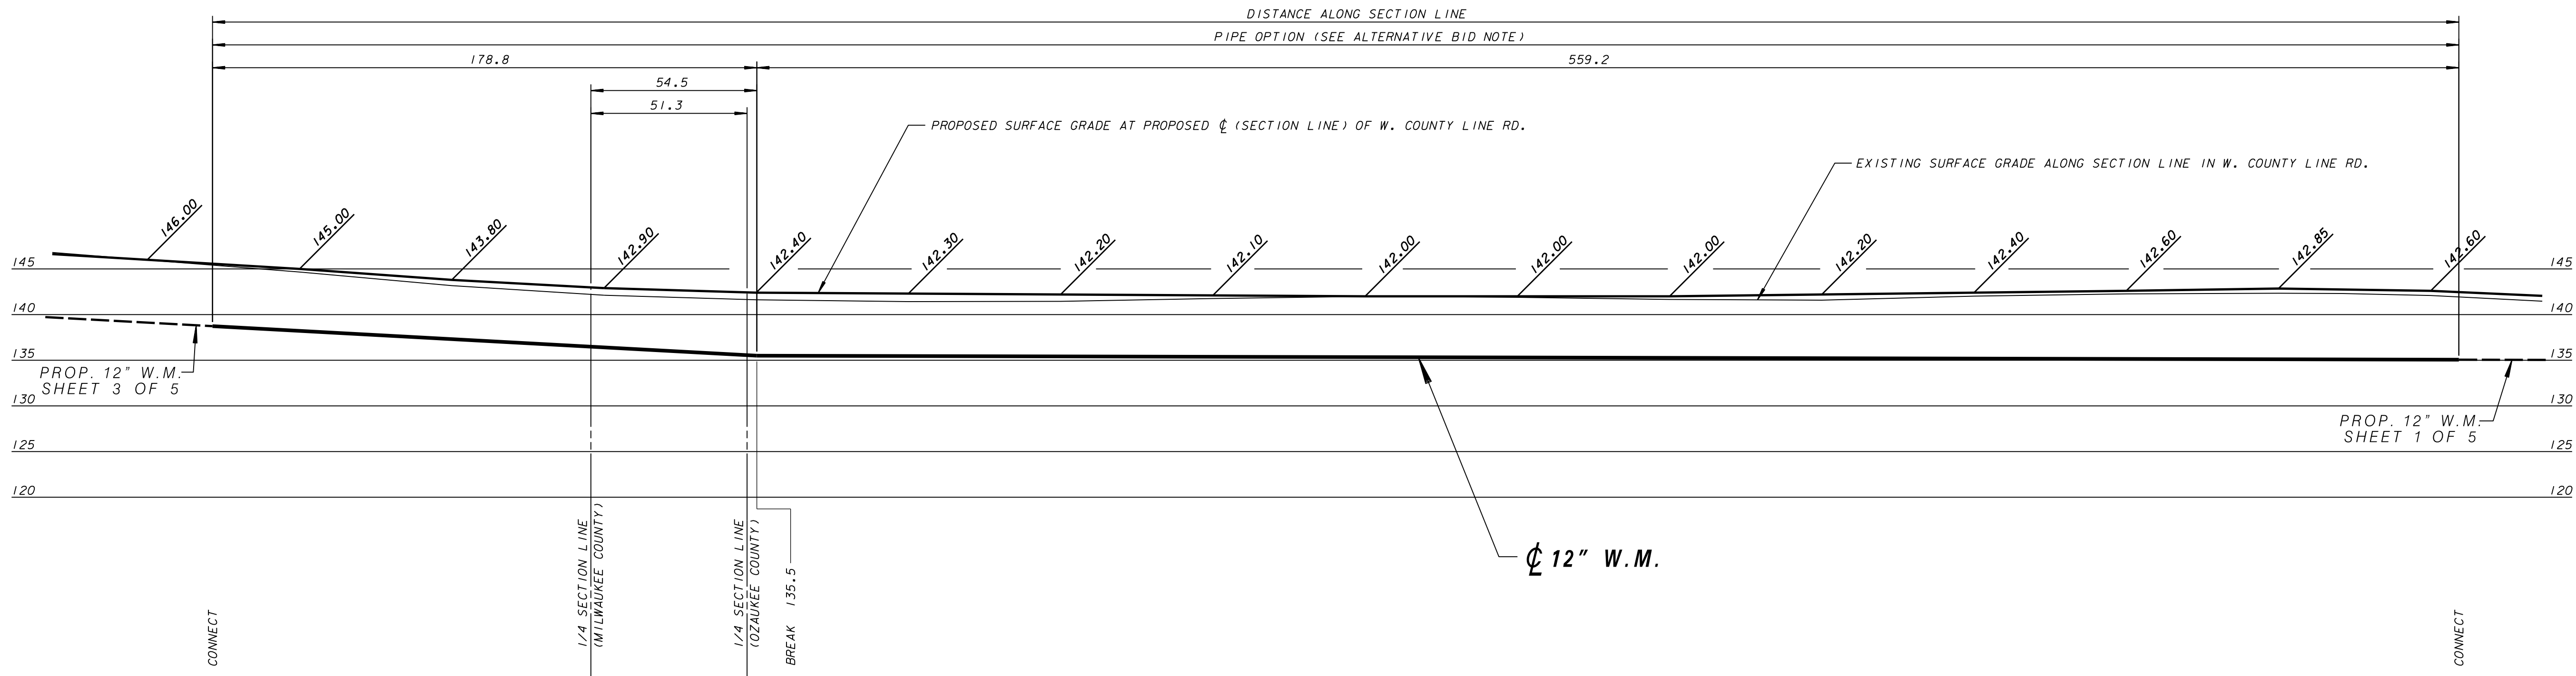

W. COUNTY LINE

CITY OF MEQUON
(OZAUKEE COUNTY)

RD.

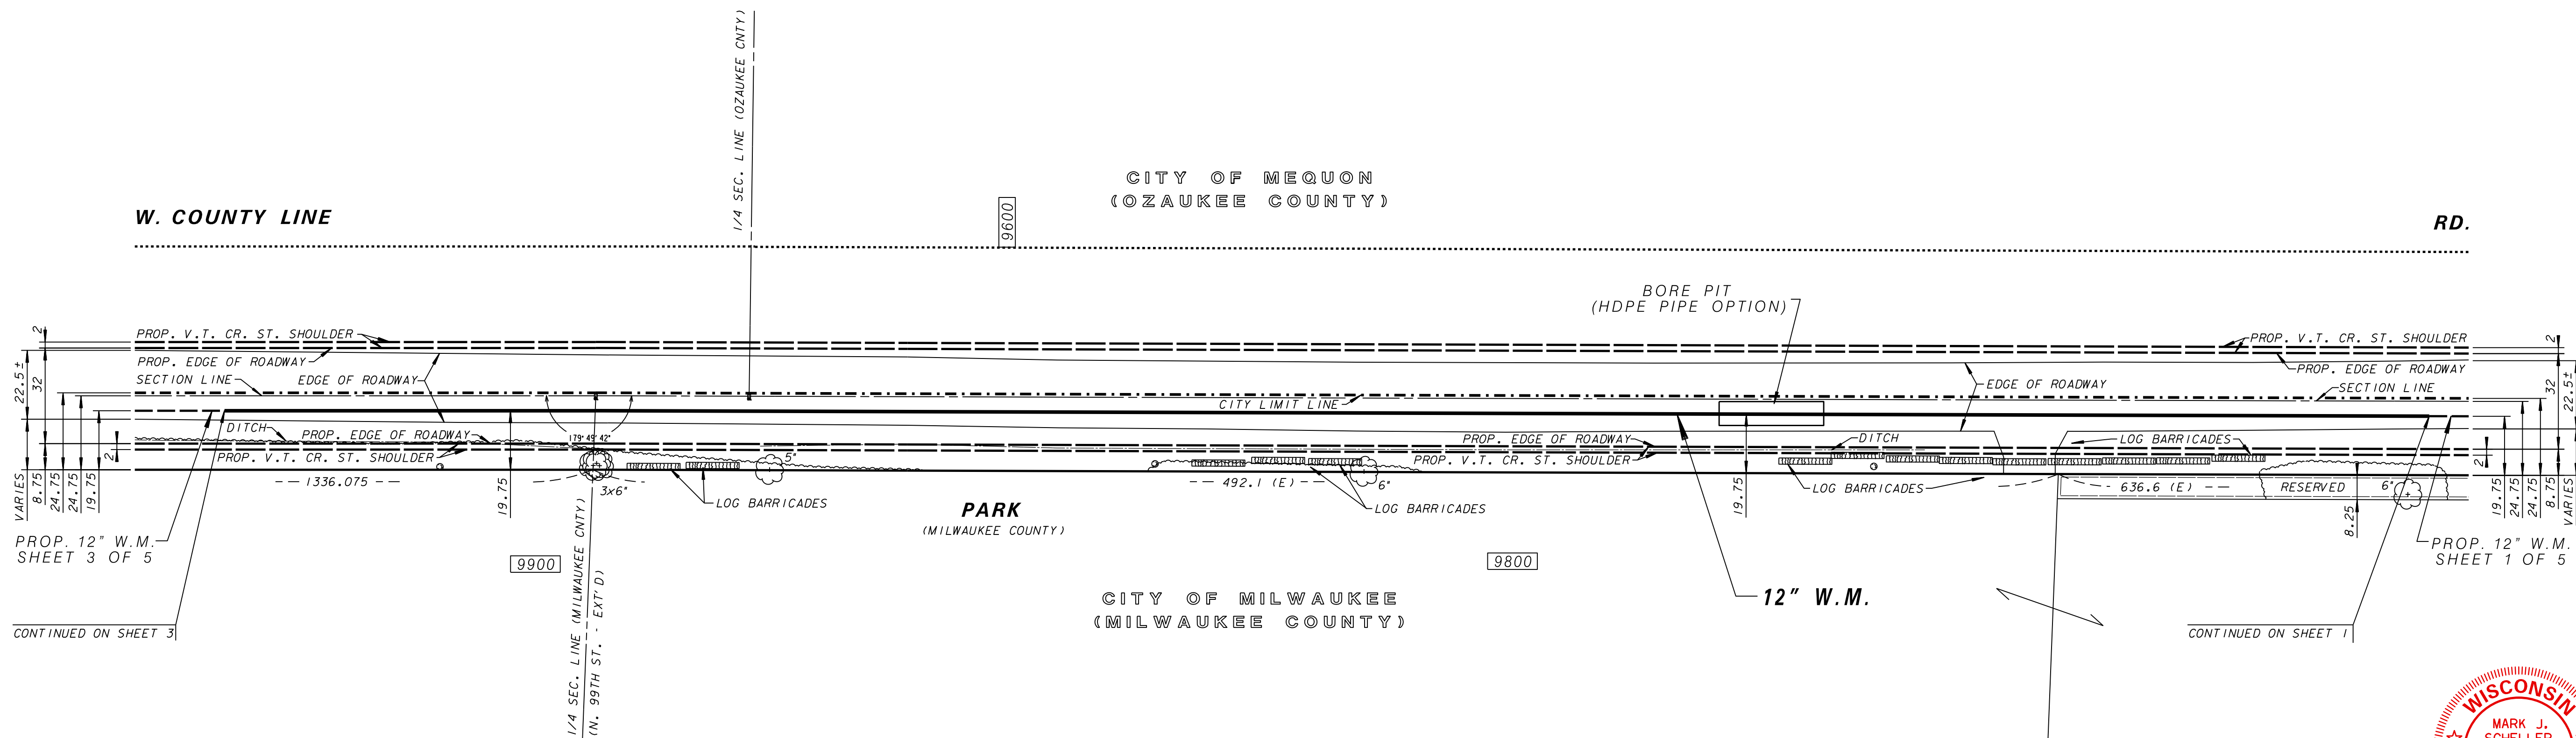

MAINTAIN TWO WAY TRAFFIC.

PAVEMENT MARKINGS MUST BE RETURNED TO ORIGINAL MATERIAL AND CONDITION.

PLEASE CONTACT TRAFFIC ENGINEERING AT 286-3632 FOR THE
INSTALLATION OF TEMPORARY "NO PARKING" SIGNS OR IF THERE
ARE ANY QUESTIONS CONCERNING THESE COMMENTS.


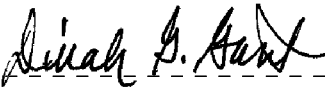

ANY PERSON WORKING IN THE PUBLIC WAY SHALL COMPLY WITH THE CITY OF MILWAUKEE, DEPARTMENT OF PUBLIC WORKS BOOKLET, "TRAFFIC CONTROL FOR CONSTRUCTION AND MAINTENANCE WORK" AND PART VI OF THE STATE OF WISCONSIN "MANUAL ON UNIFORM TRAFFIC CONTROL DEVICES".

THE SCHEDULE FOR THE PAVING OF W. COUNTY LINE RD. HAS NOT BEEN DETERMINED AT THIS TIME. DEPENDING ON THE TIMING OF THE PAVING PROJECT, THE PAVEMENT QUANTITY MAY BE REDUCED OR ELIMINATED AT THE DISCRETION OF THE CONSTRUCTION SUPERVISOR. THE BID PRICE WILL NOT BE ADJUSTED.

THE HYDRANT BRANCH PIPE AND HYDRANTS CANNOT BE INSTALLED UNTIL THE PROPOSED ROADWAY HAS BEEN PRE-GRADED. THE PAVING SCHEDULE WILL NOT BE DETERMINED UNTIL SPRING 2013. THE CONTRACTOR WILL BE REQUIRED TO RE-MOBILIZE TO COMPLETE THE HYDRANT INSTALLATIONS. ALL COSTS ASSOCIATED WITH THE SECOND MOBILIZATION SHALL BE INCLUDED IN THE UNIT PRICE BID FOR INSTALL HYDRANT.

THE CONTRACTOR SHALL CONTACT MR. NATHAN CHECK, DIRECTOR OF PUBLIC WORKS OF THE CITY OF MEQUON, TEN (10) WORKING DAYS PRIOR TO BEGINNING CONSTRUCTION.



Milwaukee Water Works		Water Engineering Department of Public Works	
W A T E R M A I N			
W. COUNTY LINE RD.			
IN FROM TO		105 FT. WEST OF N. MICHAEL CT. 470 FT. EAST OF N. 107TH ST.	
SCALE	HORIZONTAL 1" = 30' VERTICAL 1" = 10'	APPROVED   	DATE 10-17-12 MAINS DESIGN ENGINEER 10-19-12 CHIEF DESIGN ENGINEER 10-19-12 SPECIAL DEPUTY COMMISSIONER OF PUBLIC WORKS
1/4 SEC. NO. 003, 004 PLAN DATE 9/4/12 DRAWN BY J.F.S. CHECKED BY P.W.P.		SURVEY BY CONST. SECTION PROGRAM NO. 2012-201 CONTRACT NO. _____ C.C. FILE NO. 120704 WORK ORDER WT410120701 O.N. & PROJECT NO. 12-125-1 DATE ADOPED 10-16-12	
SHEET NO. 2 OF 5 PLAN FILE NO. 2012043			